OWNER:

Cosmos Development Company

11747 NE FIRST ST., SUITE 300 BELLEVUE, WA 98005 CONTACT: Oscar Del Moro

ARCHITECT:

Jackson Main | Architecture

311 FIRST AVE SOUTH, SUITE 300 SEATTLE, WA 98104 CONTACT: Robin Murphy

LANDSCAPE ARCHITECT:

Weisman Design Group


2329 E MADISON ST. SEATTLE, WA 98112 CONTACT: Andy Rasmussen

CIVIL ENGINEER:

DCI Engineers

818 STEWART ST., SUITE 1000 SEATTLE, WA 98101 CONTACT: Darren Simpson



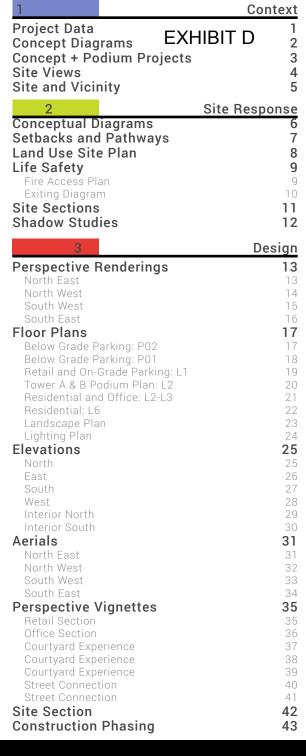








PROJECT INFORMATION:		BUILDING DATA:	
SITE ADDRESS: 16135 REDMON PARCEL NUMBER: 0 ZONING: TSQ - TC	NE 85TH ST ND, WA 98052 022505-9142 OWN SQUARE	TOTAL BUILDING AREA: TOWER A: TOWER B: PODIUM:	516,722 SF 149,839 SF 172,609 SF 194,274 SF
HEIGHT LIMIT: SITE AREA: REQUIRED RESIDENTIAL OPEN SPACE: PROVIDED: REQUIRED PUBLIC OPEN SPACE: PROVIDED:	9-STORIES 99,883 SF 24,900 SF 10,125 SF 19,997 SF 40,387 SF	RESIDENTIAL (43%) RETAIL (10%) OFFICE (19%) PARKING (28%)	223,927 SF 50,132 SF 96,401 SF 146,262 SF
UNIT DATA: TOTAL NUMBER OF UNITS: STUDIOS (3%) 1 BD (75%) 2 BD (21%) 3 BD (1%)	249 8 186 53 2	TOWER A: L2 - residential L3 - residential L4 - residential L5 - residential L6 - residential L7 - residential L8 - residential L9 - residential L9 - MEZZ - residential	149,839 SF 22,369 SF 20,251 SF 20,251 SF 20,251 SF 20,222 SF 16,359 SF 12,591 SF 4,954SF
PARKING DATA: TOTAL REQUIRED PARKING: REQUIRED RESIDENTIAL PARKING: 1.00 SPACES PER UNIT: 0.25 SPACE PER UNIT FOR GUEST: REQUIRED RETAIL/OFFICE PARKING: 2 SPACES PER 1,000 SF 30% OFFICE PARKING REDUCTION 15% BUFFER FOR RETAIL USES	496 312 249 63	TOWER B: L2 - retail L2 - office L3 - office L4 - office L5 - office L6 - residential L7 - residential L8 - residential L9 - residential	172,609 SF 2,120 SF 22,195 SF 24,116 SF 25,045 SF 25,045 SF 20,526 SF 20,526 SF 14,485 SF 13,453 SF
2 (24,200 * 0.85 + 100,830 * 0.70) / 1,000 TOTAL PARKING PROVIDED: P02 (10%) P01 (65%) STREET (1%) L1 (24%)	369 40 239 6 90	L9 - MEZZ - residential PODIUM: L1- retail L1-MEZZ - retail L1 - parking P01 - parking P02 - parking	5,098 SF 194,274 SF 35,270SF 12,742 SF 38,701 SF 89,548 SF 18,013 SF
TOTAL BICYCLE PARKING:	335		

Project DataProject Statistics and Code Summary







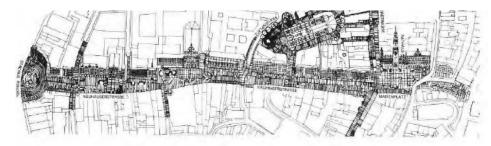






Pedestrian streets Subway stations

Parks --- Inner ring

Aerial view of the central pedestrian spine connecting Munich's two major medieval

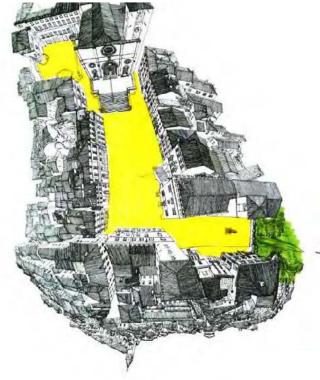



THE STRUCTURE OF THE SQUARE

Spectavoid among the transitensarial works of successful and the sum of the s



"Two roads diverged in a yellow wood ..." robert frost

Concept Diagrams
History of Urbanism


















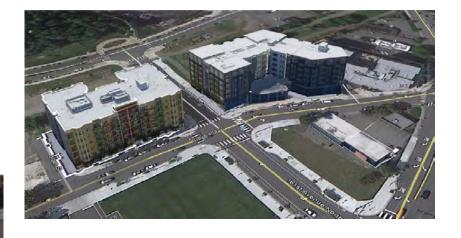



Multifamily Podium Projects at Cleveland and 161st





Veloce Multifamily Podium Project



Concept + Podium Projects
Neighboring Projects












View 1





View 2

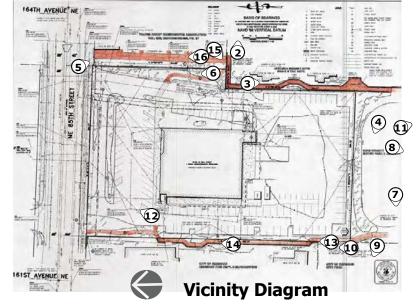

View 8













View 10



View 4

View 15 View 16

Redmond City Center 16135 NE 85th Street, Redmond, WA

Site Views *Existing Vicinity*










Mid Block Connector Diagram

Site and Vicinity
Mid-Block Connector Diagram







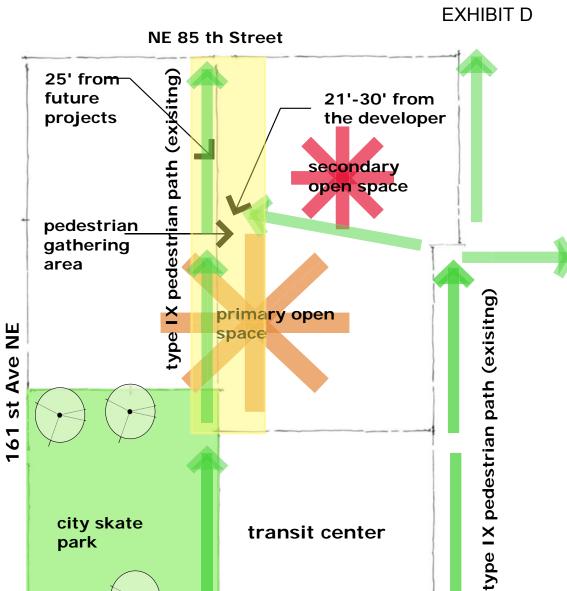


Conceptual Diagrams *Existing Pathways & Proposed Open Spaces*





NE 83rd Street

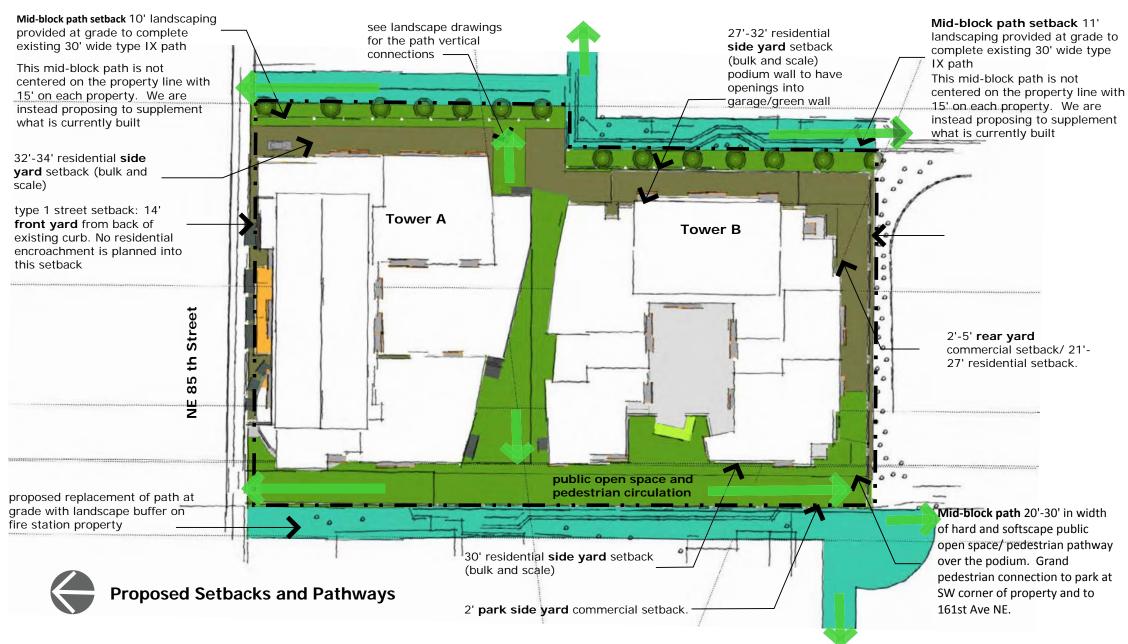

Setbacks and Pathways City of Redmond Zoning Requirements





Design Review Presentation
December 17, 2015

Redmond Land Use Standards

Front setback = 14' wide sidewalk, measured from back of street curb.

Rear Setback = 0' for commercial and garages associated with commercial mixed-use. 10' for residential,

Park setback, rear and side = 14 feet for commercial and residential uses.

Side setback = 0' for commercial and garages associated with commercial mixed-use. Per Table 21.10.130B, the side yard residential setback shall be 26' for this building.

Mid-block path setback (both sides) = 15' from centerline of path (to create the 30' pathway at grade, with 15 feet on each side of property line.

Courtyard separtations = 55' in courtyards, no standard between towers. 45'-55' provided between tower A and B.

OPEN SPACE CALCULATIONS:


Residential Common Open Space 19,978 sf provided (max 20% of site area)

Public Open Space

19,978 sf (max 20% of site area)

Proposed Landscaping at grade in order to complete existing type IX path system

Existing Landscaping at grade this includes both hardscape and softscape

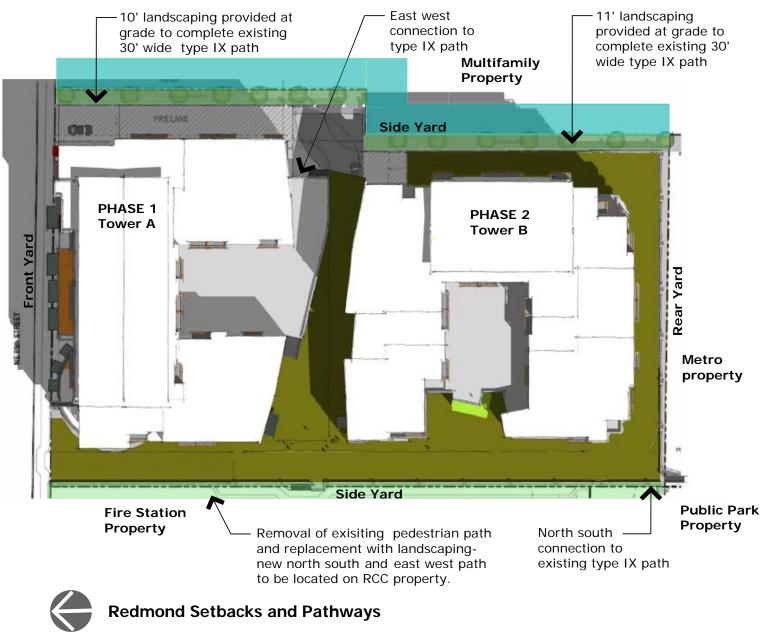



Project Conformance to Zoning







Redmond City Center 16135 NE 85th Street, Redmond, WA

Fire Comments and Responses:

Multi family developments with greater than 100 units are required to have not less than 2 access points to the public road system, per Appendix 2. We are proposing 2 EV access points shown on this page.

Where are the lobbies for the two towers, how do fire police and non resident public interact with this building? How do people get off the podium? Where are the stair tower discharge points at grade? 12/26/13 Show the location of the street level termination of the required roof access stairways for each tower. See pages 13-15

Fire access roadways are required to be with in 150' of all portions of the exterior wall first level. How is this achieved for phase 2 and the south side retail? Suggest a grade level access road on east side from 85th sout to 83rd. Possiblly depressed to access garage level. 12/26/13 the parking garage with the two residential towers are a single building, provide an access road that complies with the requirements of RFD Standard 2.0. this layout provides a fire loop around the entire complex.

Water line and hydrant spacing/locations? 4 hydrants are required with a fire flow not to exceed 3500 gpm. See civil Information

What building code section is this structure being constructed to, are you planning on using IBC Section 510.2? This structure is considered a single building with two towers, one address and unit numbers will be assigned during the Civil review process. We are proposing to classify this complex as one structure with out a horizontal fire separation. See page 11

When a floor level is greater than 75' above the lowest level of fire department access, the building is considered a high rise structure per the building and fire codes. Yes it is a highrise. See page 11.

High rise buildings in Seismic category "D" require a secondary water supply for the fire sprinkler system sized in accordance with 2012 IFC Section 903.3.5.2. See page 13 for proposed location of secondary water vault.


This building will require the installation of an emergency responder radio system, to be installed in accordance with RFD Standard 18.0. Understood

All high rise builidngs are to be provided with a fire command center in accordance with IFC Section 508. Understood

Standby power is required in all high rise buildings per IFC 604.2.14. Understood

Are you anticipating a fire pump to be installed to meet your fire sprinkler demands? If so sho w the proposed location. See civil Information

Provide the total gross square footage of the parking garage, the north and south towers to calculate the required fire flow to the building. Due the 3 hour horizontal seperation, the distance between the towers, and the type of construction seperate fire flow calulations will be done. See Page 8

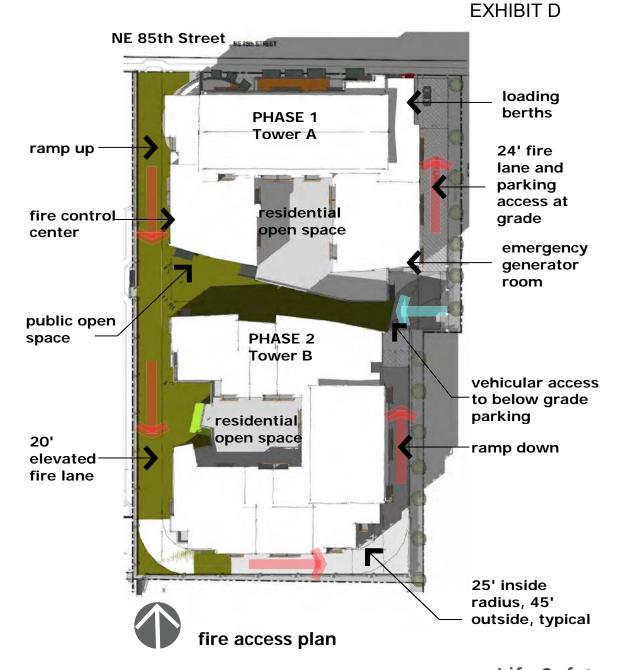













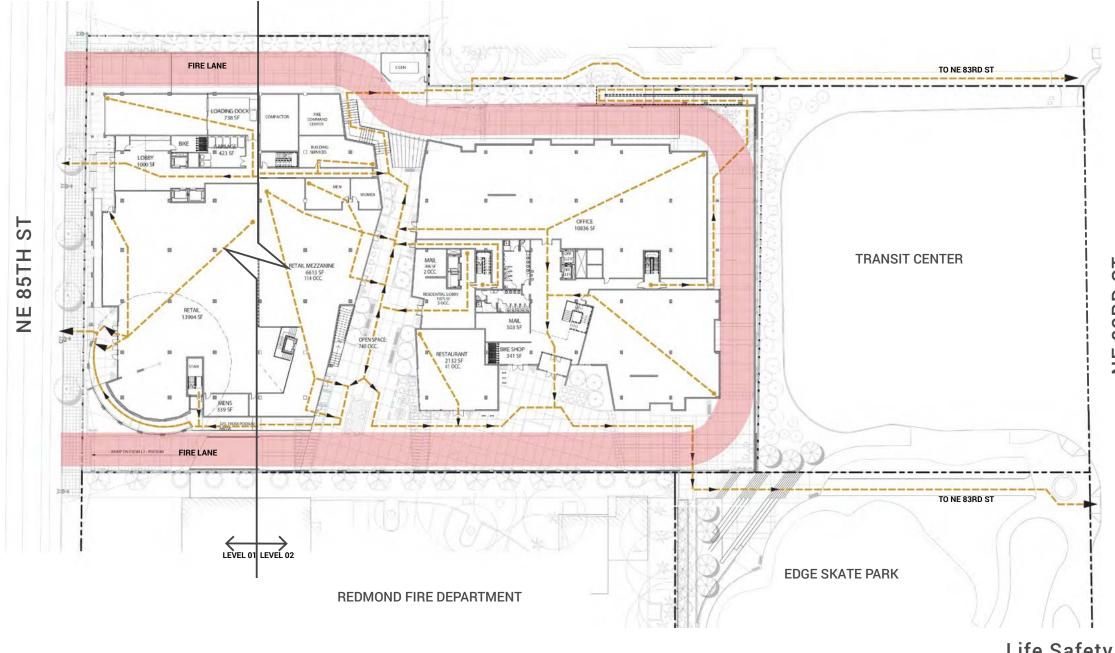





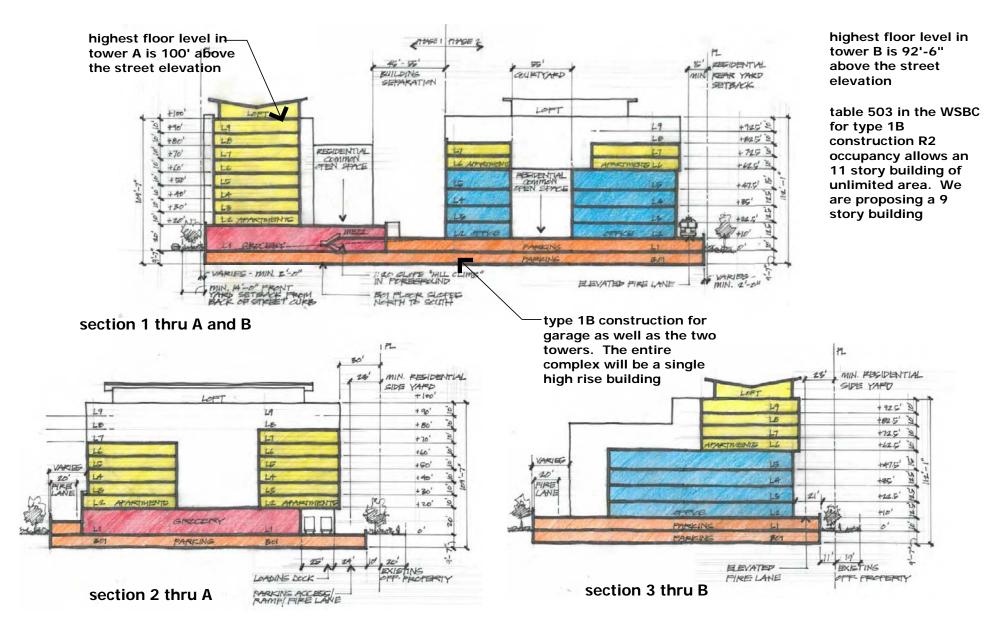

Site Sections









SUMMER SOLSTICE









2:00 p.m.

SPRING/FALL EQUINOX











Redmond City Center 16135 NE 85th Street, Redmond, WA



2:00 p.m.

Shadow Studies
Typical One Year Cycle









Perspective Renderings
North East









Perspective Renderings
North West









Perspective Renderings
South West










Perspective Renderings
South East







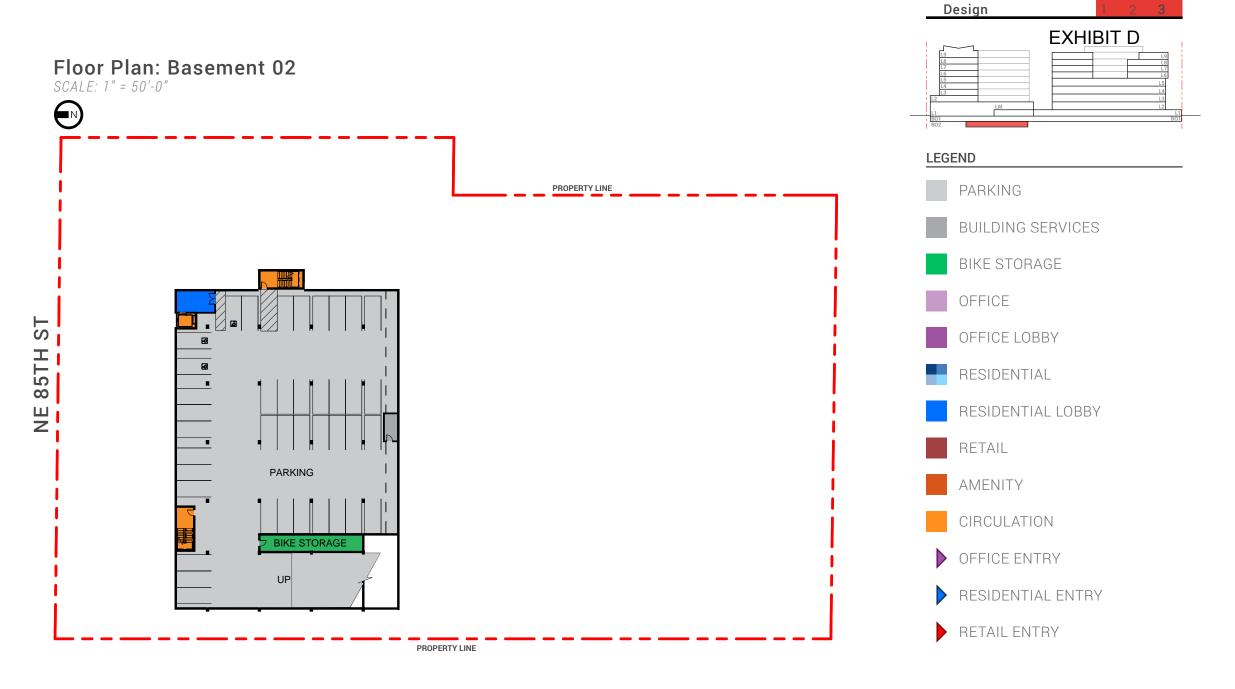

Floor Plans
Below Grade Parking: B2






Floor Plan: Basement 01

SCALE: 1" = 50'-0"



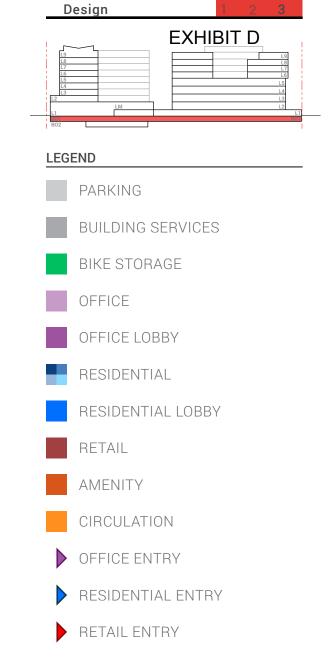

Floor Plans


Below Grade Parking: B1








Floor Plan: Level 1 SCALE: 1" = 50'-0"

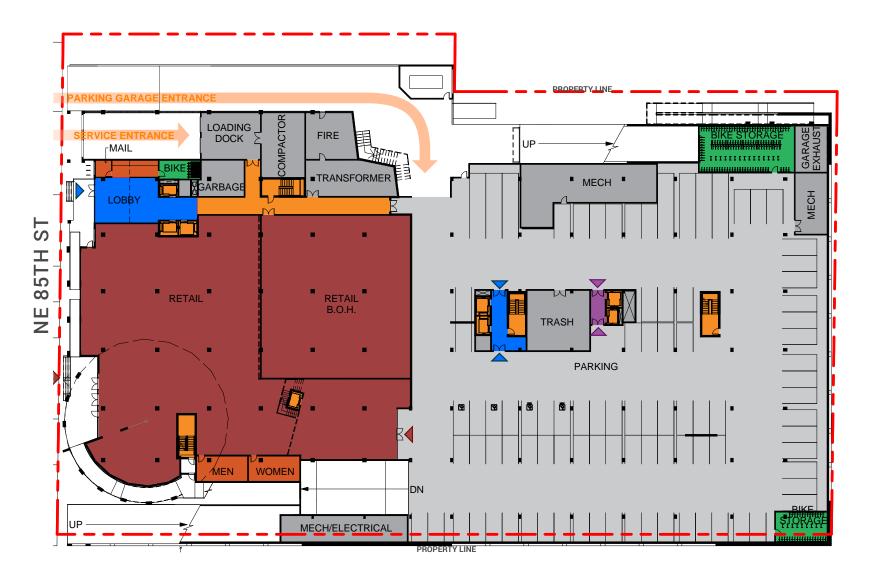

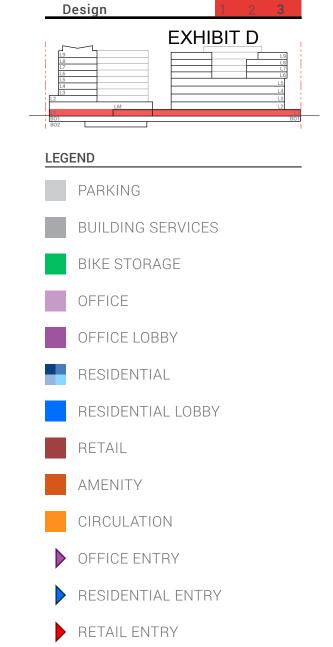


Floor Plans

Retail and On-Grade Parking: L1







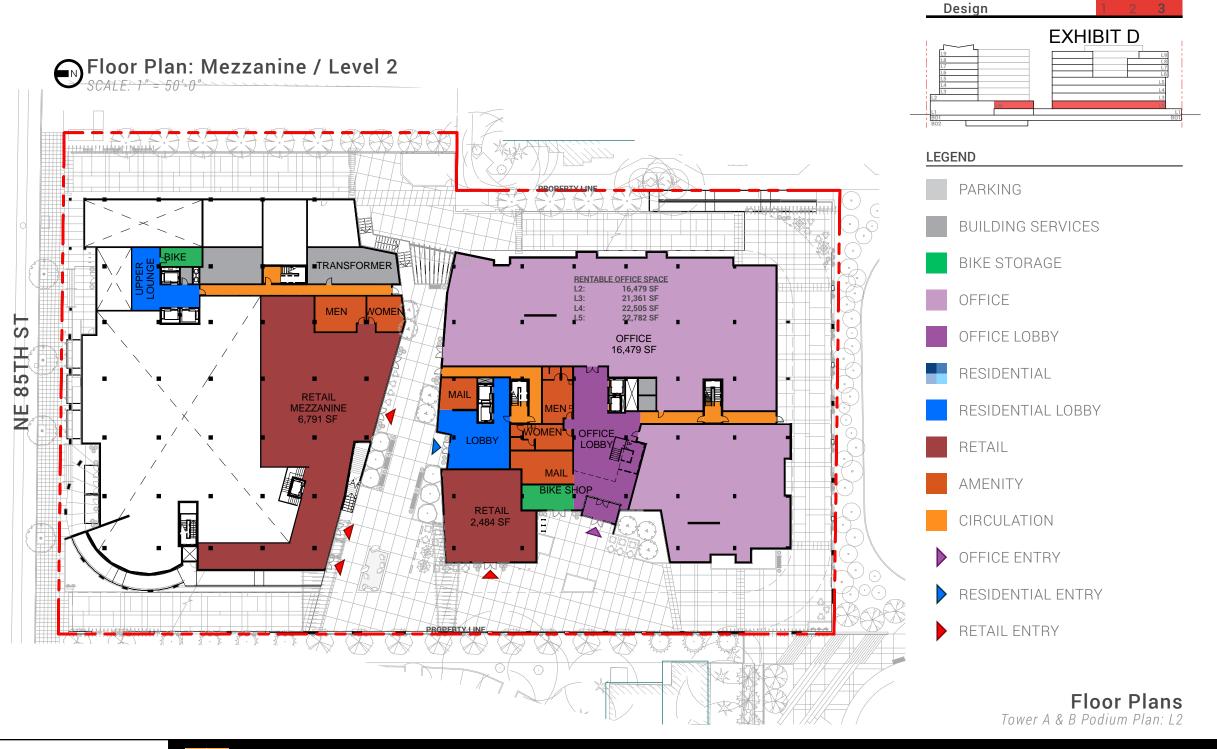

Redmond City Center 16135 NE 85th Street, Redmond, WA








Floor Plan: Level 2 / 3 SCALE: 1" = 50'-0"



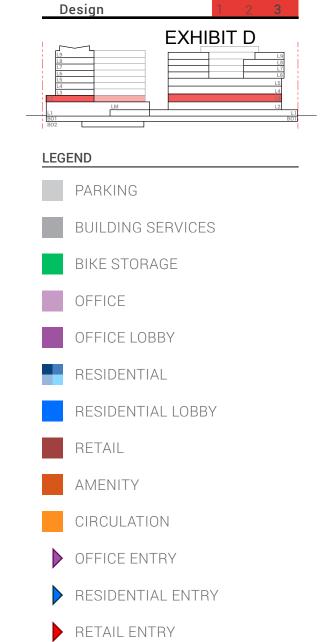

Floor Plans


Residential and Office: L2-L3





Floor Plan: Level 6 SCALE: 1" = 50'-0"



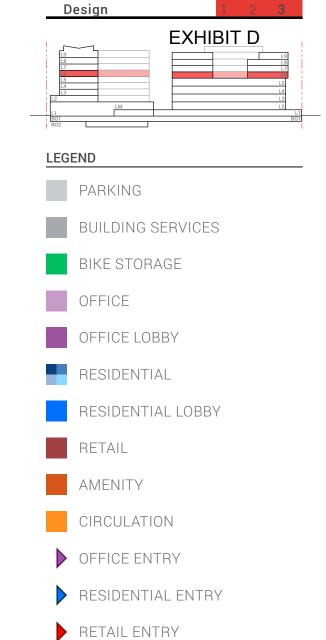

Floor Plans
Residential: L6














2329 E MADISON ST

SEATTLE WA 98112

206-322-1732

WWW.WDGINC.COM



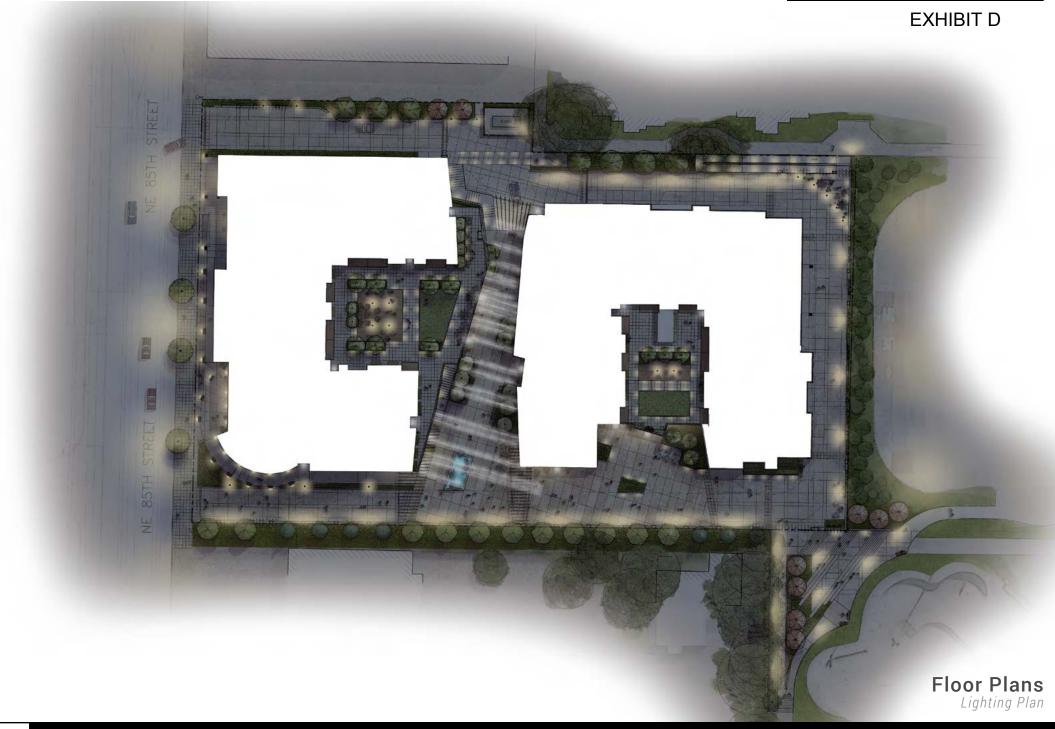







Elevations North










Elevations


East





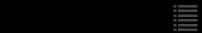

Design Review Presentation December 17, 2015

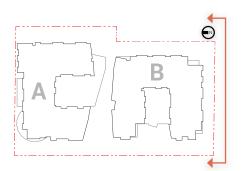



ElevationsSouth










Elevations *West*







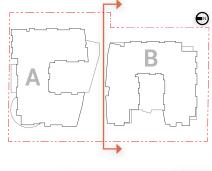

THE REAL PROPERTY. В1

Pre-finished metal panel, smooth faced: Shagreen SW-6422

Pre-finished louver screen around mech equipment

Aluminium windw wall with alternating insulated glazing panels and black-gray spandral panels.

Pre-finished metal panel, smooth faced: Steely Gray SW-7664

Pre-finished metal panel, smooth faced: Wall Street SW-7665.

Aluminium curtain wall with alternating insulated glazing panels and black-gray spandral panels.

Pre-finished steel trellis elements Wall Street SW-7665

Cast in place concrete podium wall w/ board formed podium pilasters & trellis supports


Elevations *Interior North*








В2

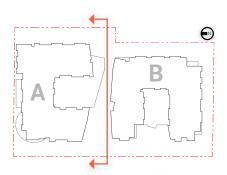

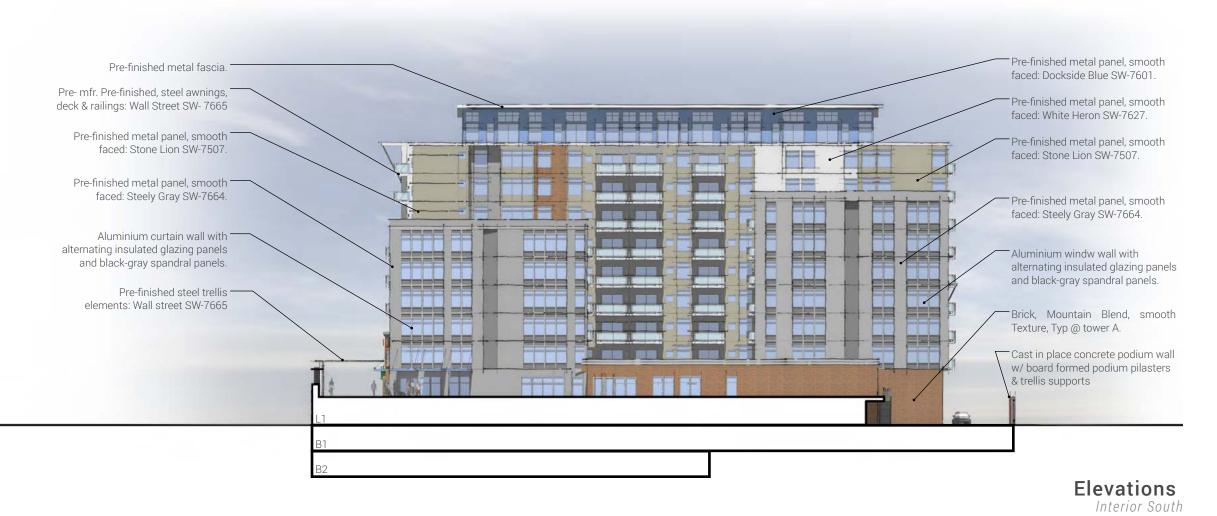









Aerials North East









Aerials North West









Aerials South West









Aerials South East










Perspective Vignettes

Retail Section







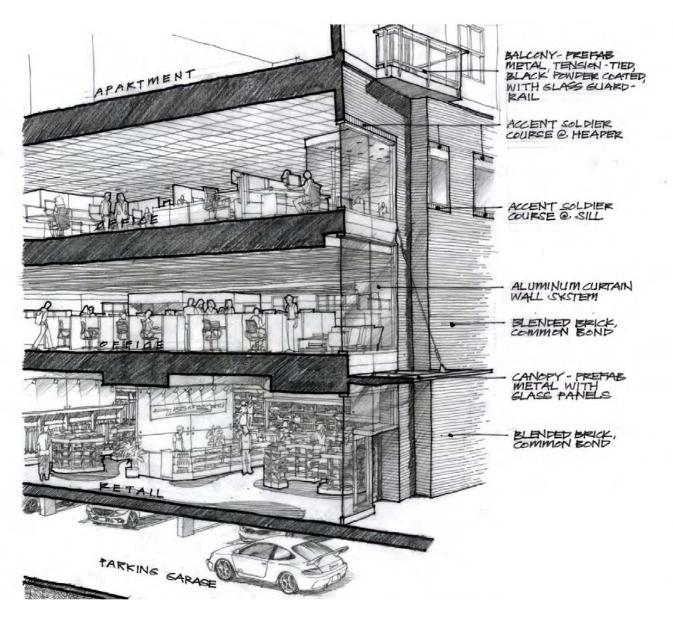

Perspective Vignettes
Office Section







Perspective Vignettes

Courtyard Experience








Redmond City Center 16135 NE 85th Street, Redmond, WA

Perspective Vignettes
Courtyard Experience







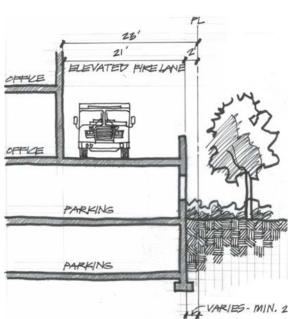


Perspective Vignettes

Courtyard Experience







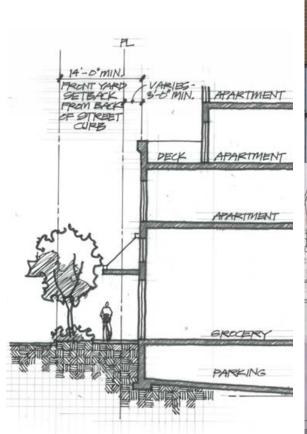



Design Review Presentation

December 17, 2015


Perspective Vignettes
Street Connection










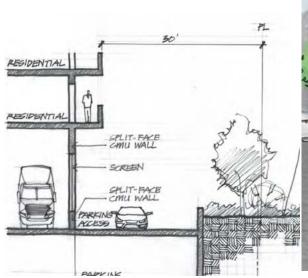

Perspective Vignettes
Street Connection





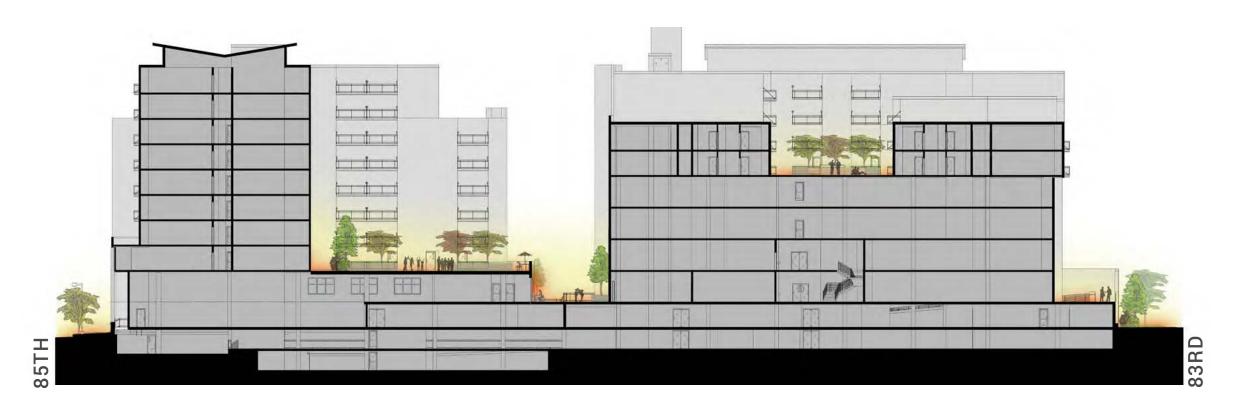


North- South Site Section


Amenity Space







PHASE 3 EXHIBIT D

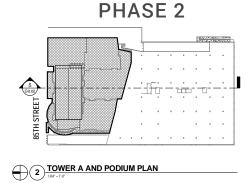


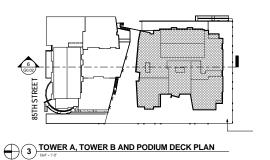


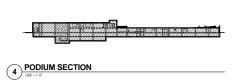



PHASE 1

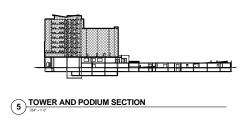

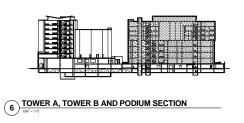

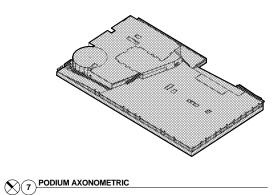

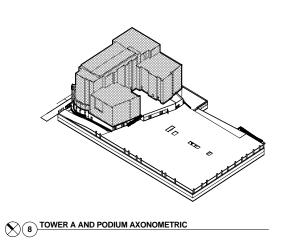

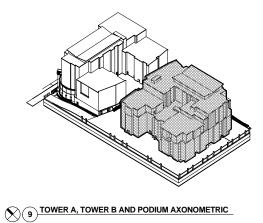


Construction Phasing
Proposed Three Phase Cycle






EXHIBIT D

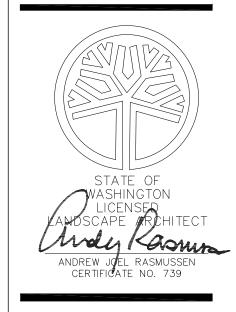


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LANDSCAPE PLAN ENLARGEMENT

EXHIBIT D




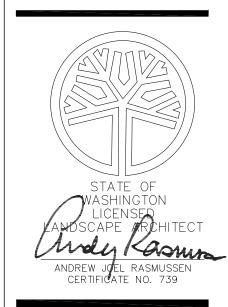

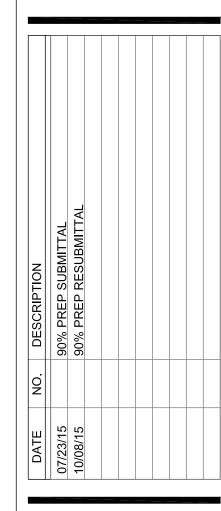
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PROJECT NO.:

LANDSCAPE PLAN ENLARGEMENT




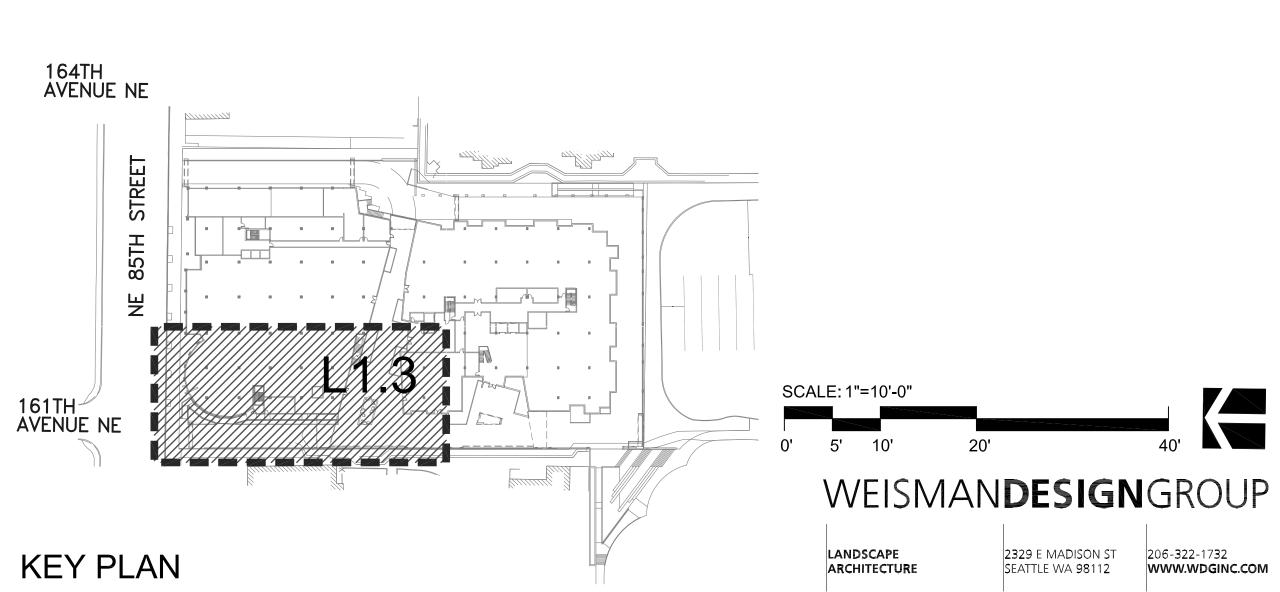


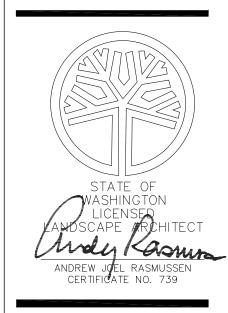
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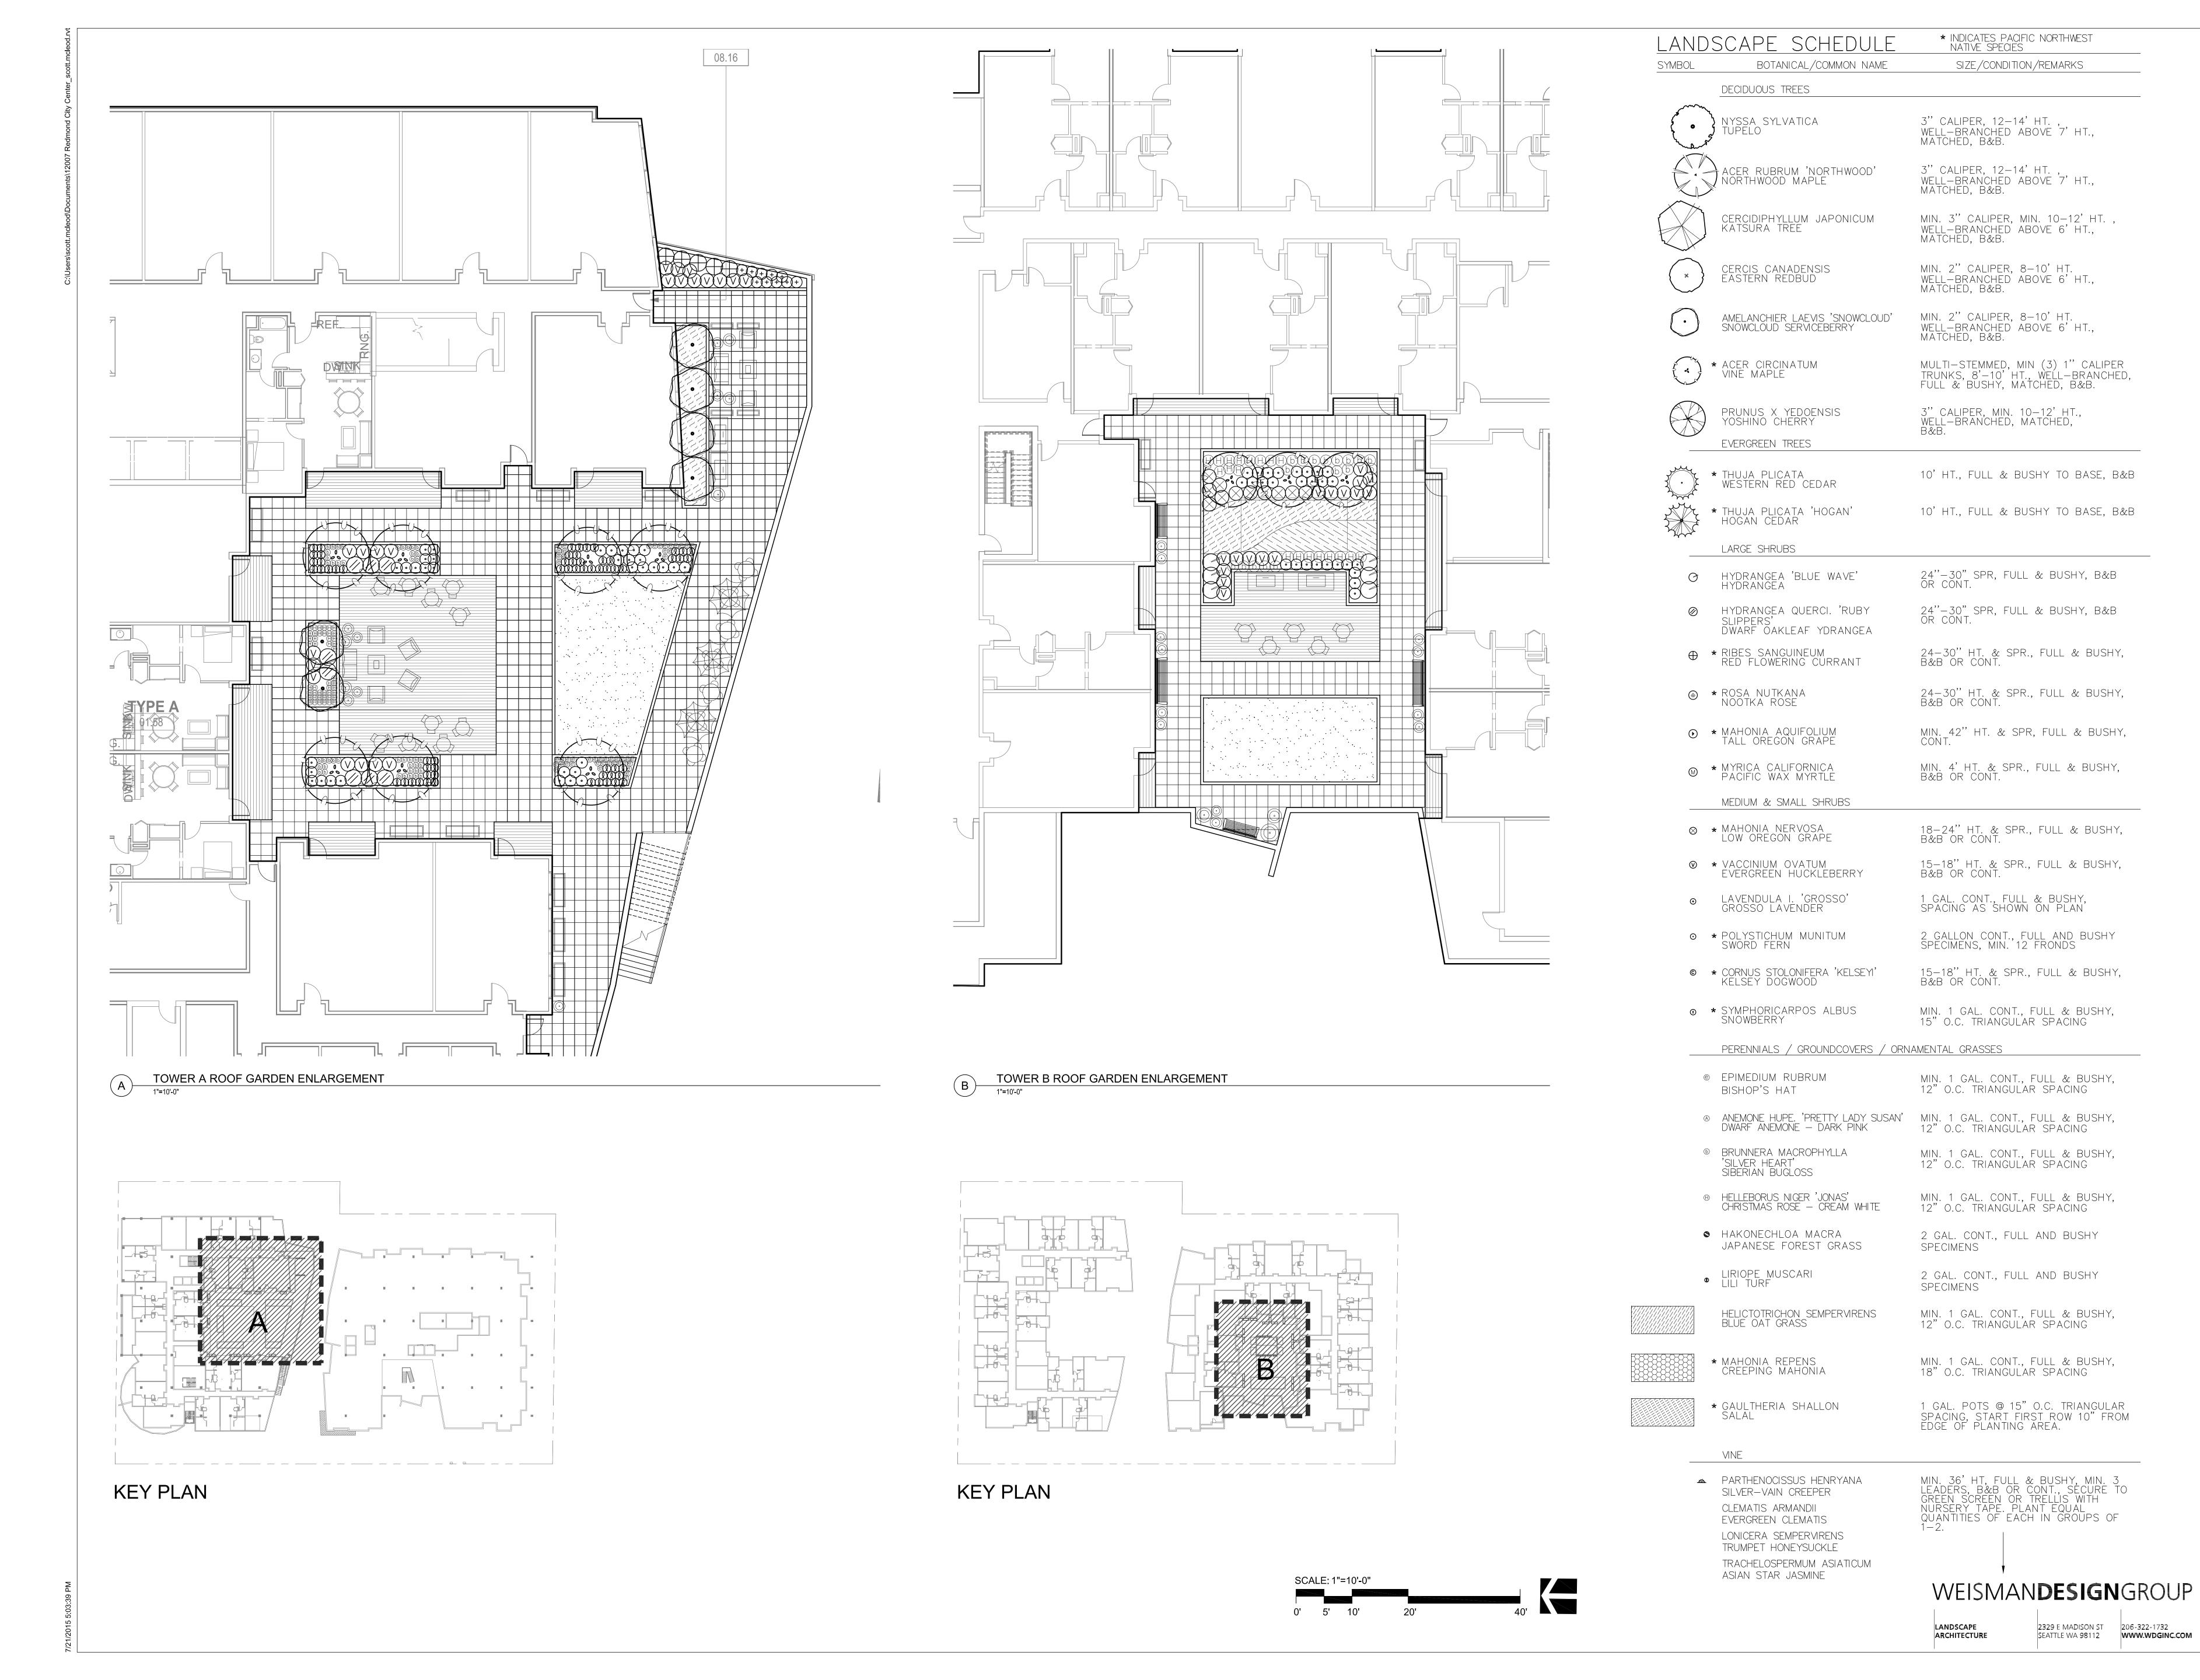




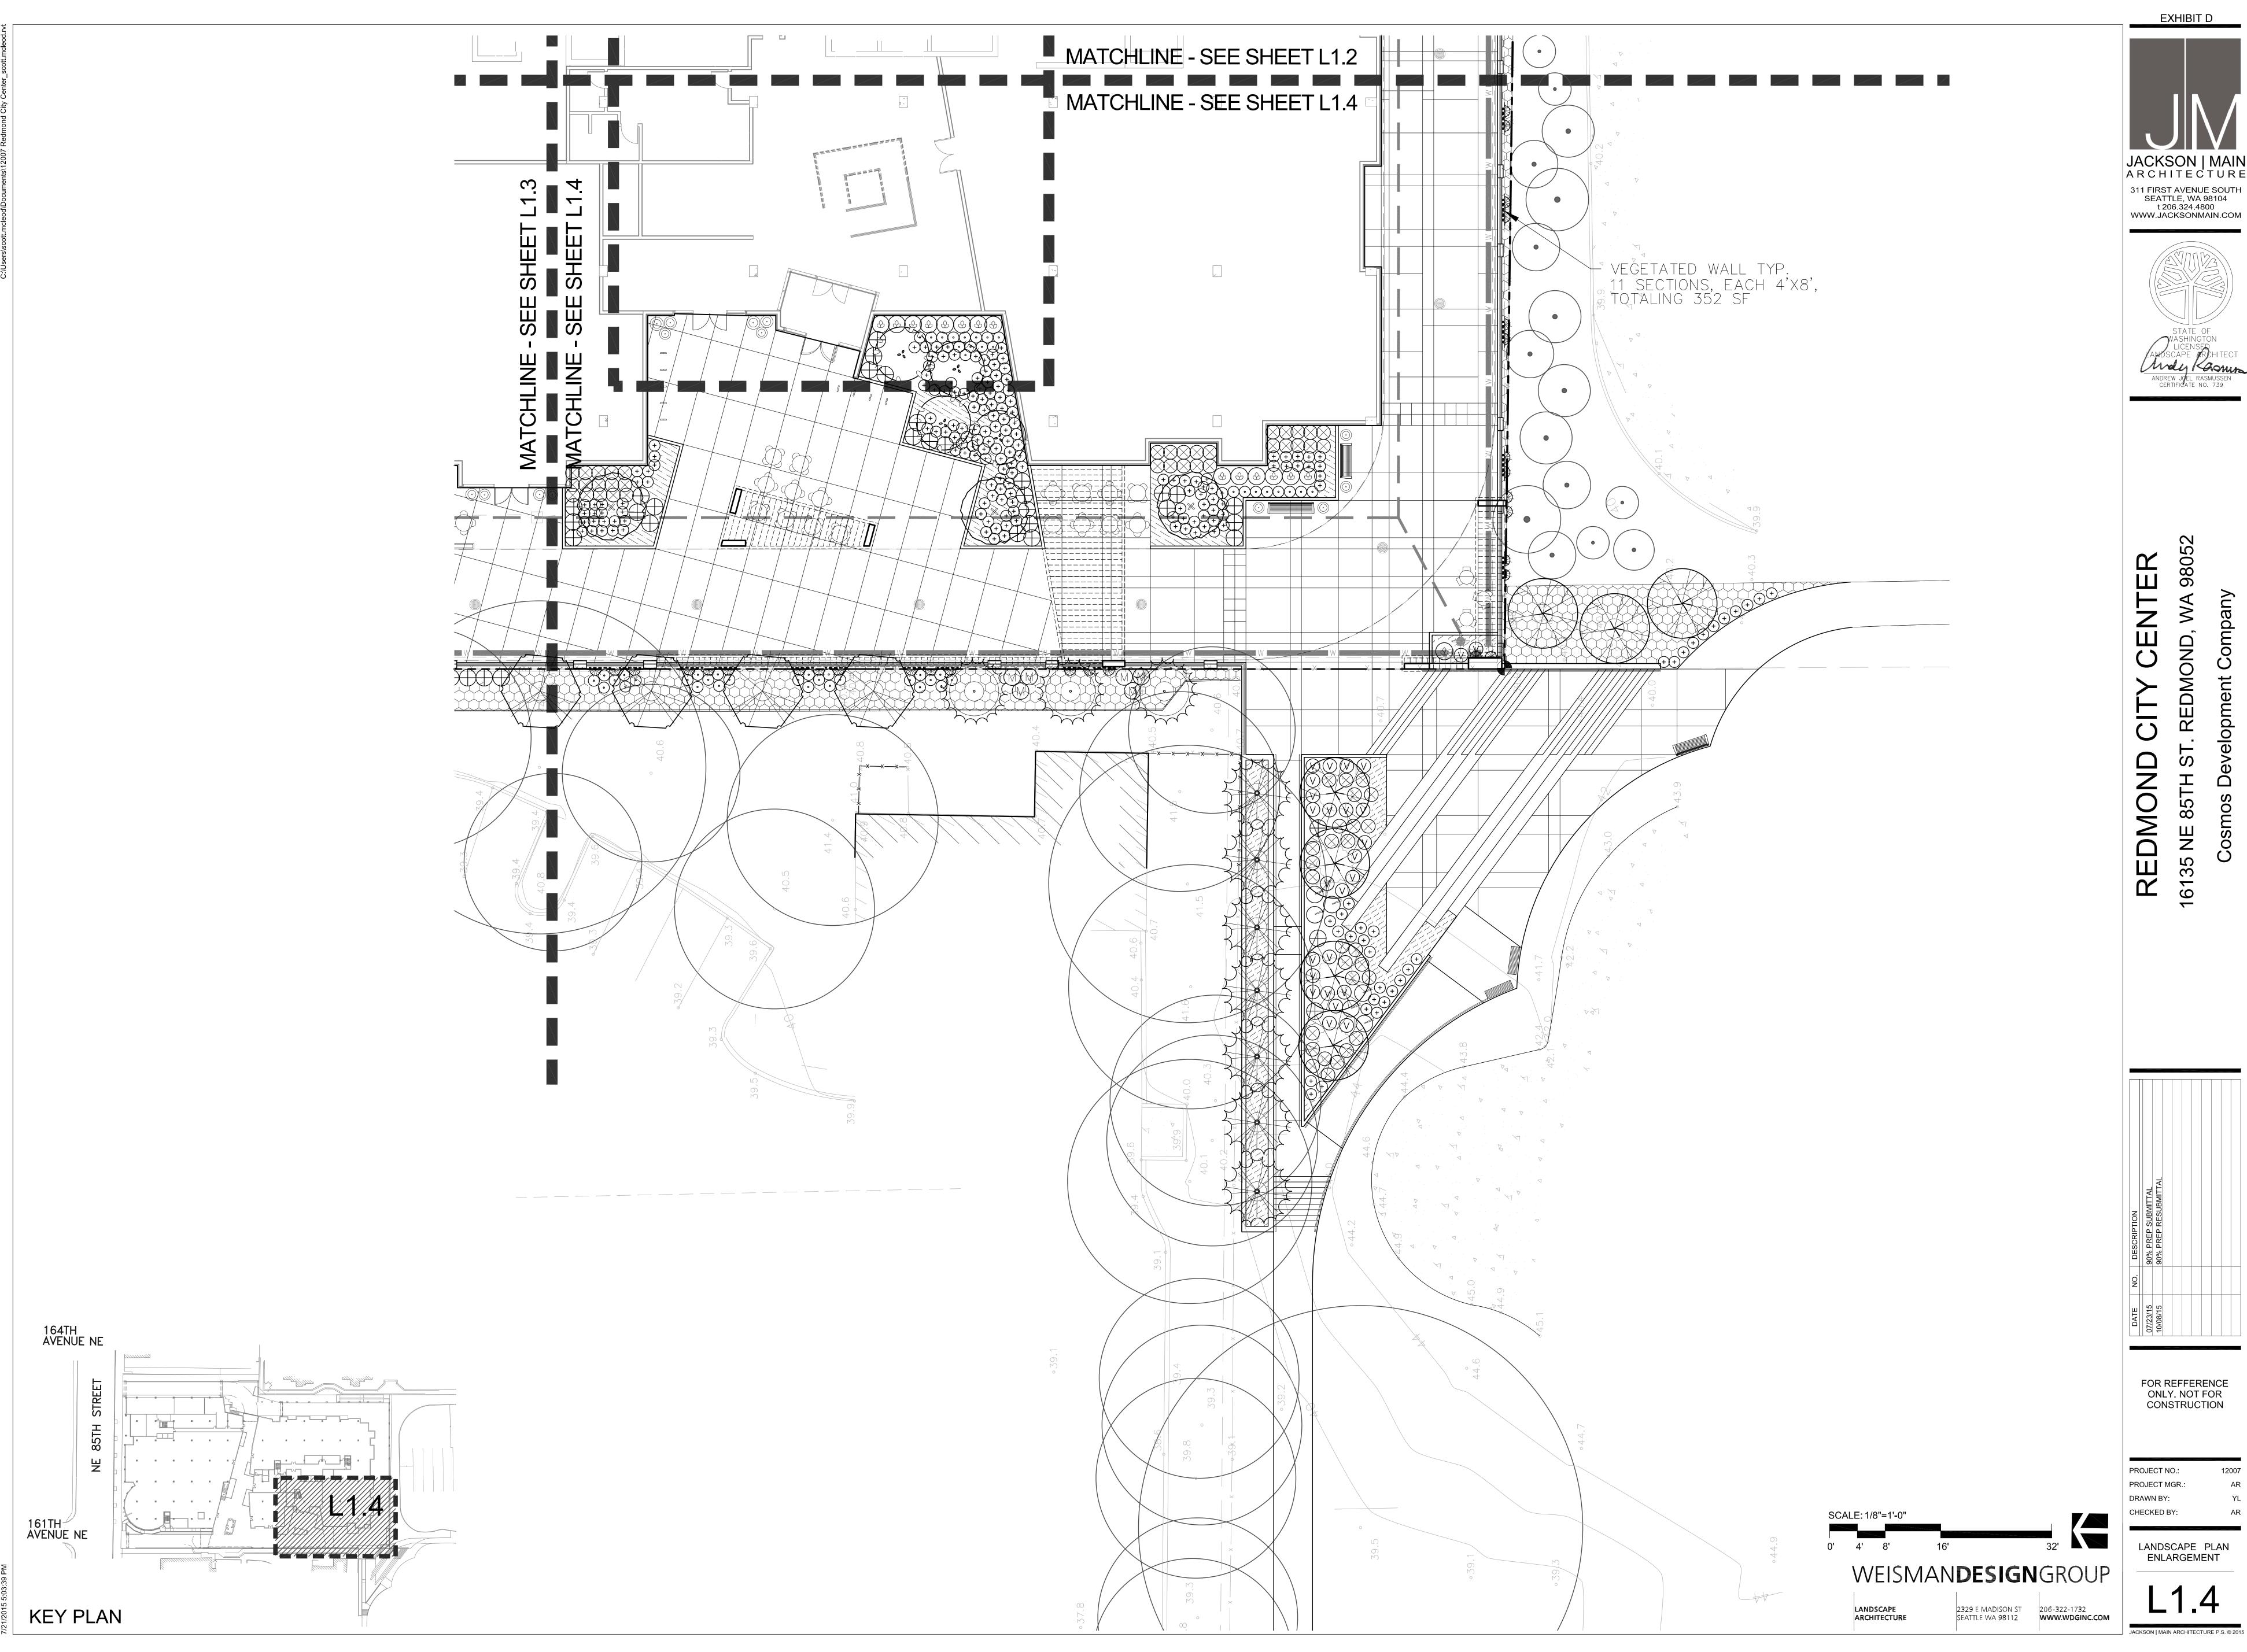

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LANDSCAPE PLAN ENLARGEMENT

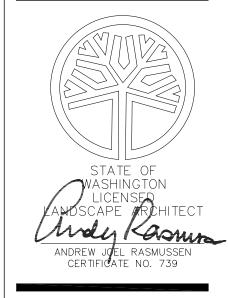

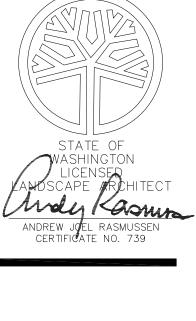JACKSON | MAIN ARCHITECTURE 311 FIRST AVENUE SOUTH SEATTLE, WA 98104 t 206.324.4800 WWW.JACKSONMAIN.COM



JND CILY CENIER 5TH ST. REDMOND, WA 98052


15 90% PREP SUBMITTAL
15 90% PREP RESUBMITTAL

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PROJECT NO.:
PROJECT MGR.:
DRAWN BY:
CHECKED BY:

LANDSCAPE PLAN
ENLARGEMENTS &
LANDSCAPE SCHEDULE


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Redmond City Center 16135 NE 85th Street, Redmond, WA Material Board
Podium and Tower A




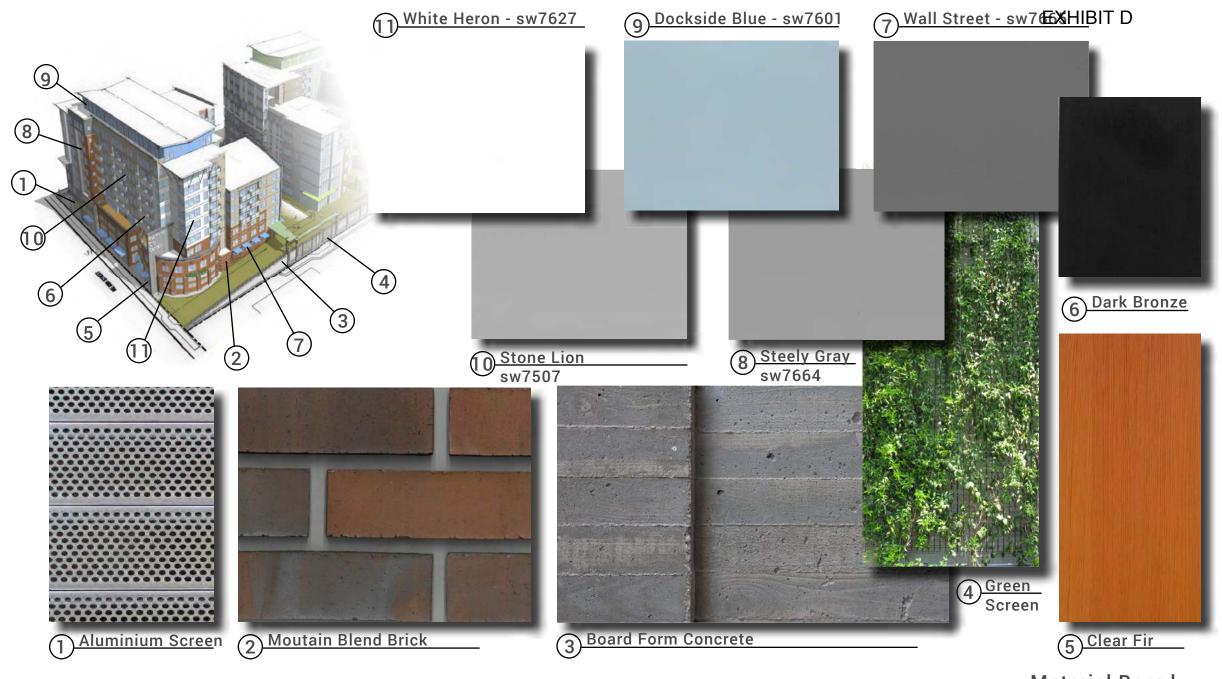





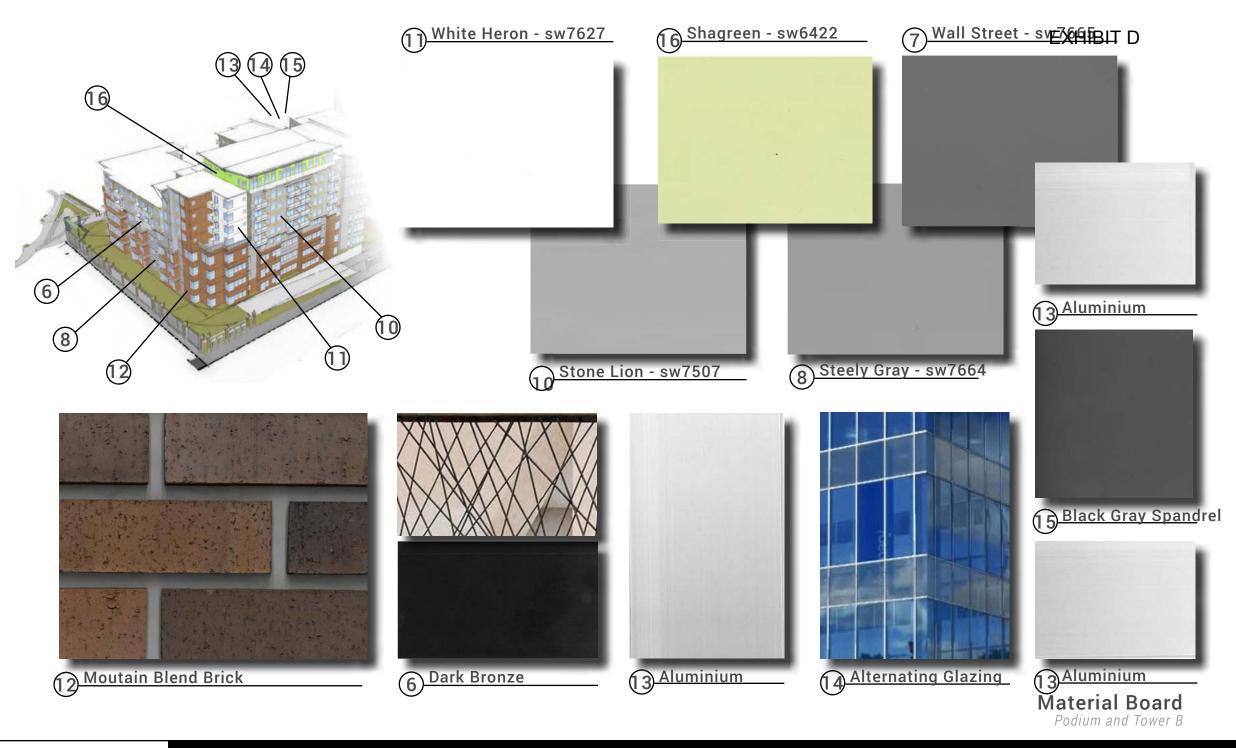

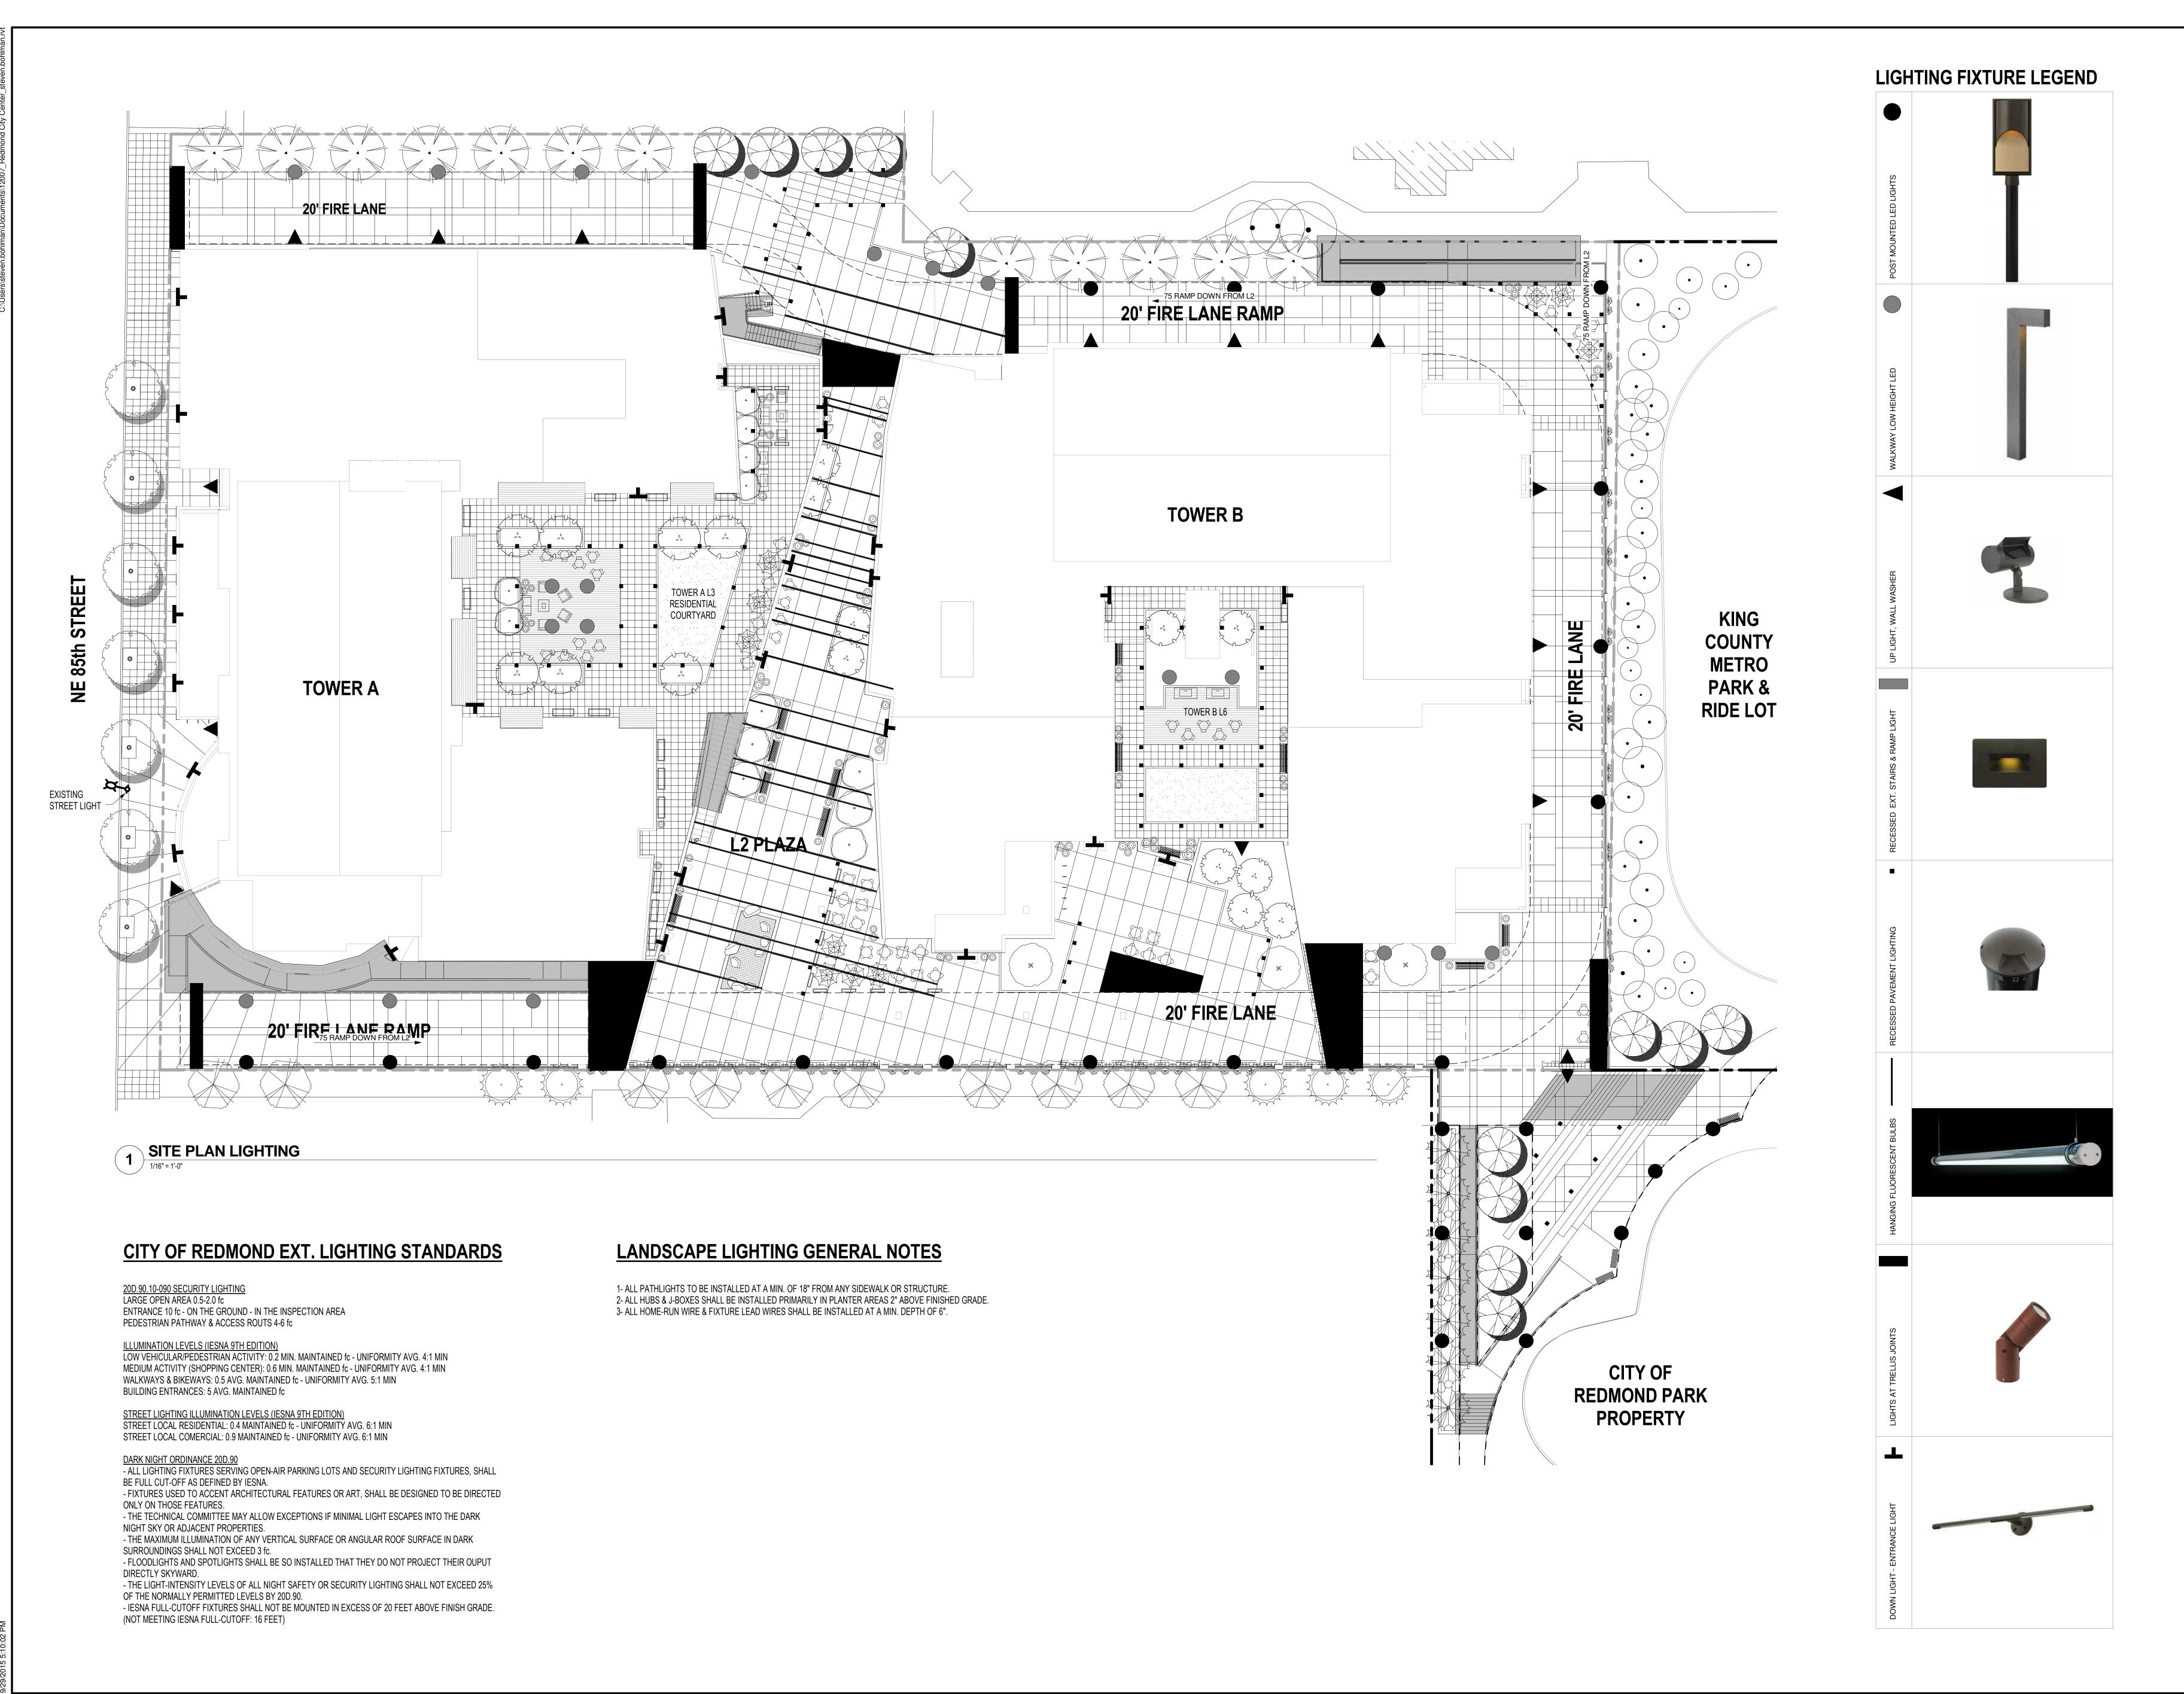

T. REDMOND, WA 98052

DESCRIPTION

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PROJECT NO.: 1200
PROJECT MGR.: Designed
DRAWN BY: Author
CHECKED BY: Checket

LANDSCAPE
LIGHTING PLAN